



MCMURRAY
MÉTIS

Metis Cultural Centre

May 2021

McMURRAY MÉTIS LOCAL





**MCMURRAY
MÉTIS**

Cultural Centre Contract Signing Ceremony

We are very pleased to be partnering with Casman for the construction of the \$44 million Metis Cultural Centre, they are a well-known and respected member of our local business community with a proven track record of success.




Nearly 5,000 views!

CLIMATE LENS ASSESSMENT

OBJECTIVES OF THE CLIMATE LENS

- The **climate lens assesses opportunities to reduce carbon pollution** and helps identify **when and how a project should be adapting** project design to better withstand impacts of climate change.
- There is **guidance** to support the application of the lens to infrastructure projects.
- Climate change resilience assessments submitted to Infrastructure Canada **require a qualified party provide an attestation** that the assessment was carried out according to this guidance.

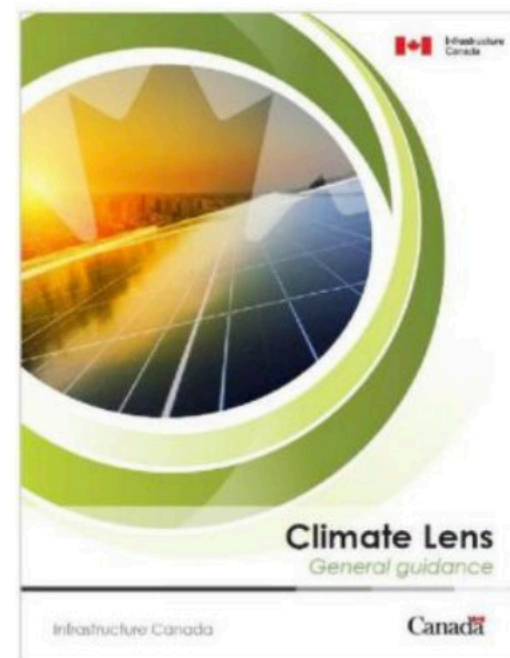

http://bit.ly/INFC_climatelens

Please direct questions to:
infcc.info.infcc@canada.ca

ONE PLANET LIVING

									
Health and happiness		Encouraging active, social, meaningful lives to promote good health and wellbeing							
Equity and local economy		Creating safe, equitable places to live and work which support local prosperity and international fair trade							
Culture and community		Nurturing local identity and heritage, empowering communities and promoting a culture of sustainable living							
Land and nature		Protecting and restoring land for the benefit of people and wildlife							
Sustainable water		Using water efficiently, protecting local water resources and reducing flooding and drought							
Local and sustainable food		Promoting sustainable humane farming and healthy diets high in local, seasonal organic food and vegetable protein							
Travel and transport		Reducing the need to travel, encouraging walking, cycling and low carbon transport							
Materials and products		Using materials from sustainable sources and promoting products which help people reduce consumption.							
Zero waste		Reducing consumption, re-using and recycling to achieve zero waste and zero pollution							
Zero carbon energy		Making buildings and manufacturing energy efficient and supplying all energy with renewables							

2021-03-19 2:44:14 PM



NOTE
• ARCHITECTURAL DATUM 100' = 250.9 m GEO RELATIVE TO SEA LEVEL

THIS DRAWING MUST NOT BE SCALED. THE GENERAL CONTRACTOR SHALL VERIFY ALL DIMENSIONS, DATUMS AND LEVELS PRIOR TO COMMENCEMENT OF WORK. ALL ERRORS AND OMISSIONS MUST BE REPORTED IMMEDIATELY TO THE CONSULTANT. THIS DRAWING IS TO BE USED IN CONJUNCTION WITH ALL OTHER DRAWINGS AND SPECIFICATIONS. VARIATIONS AND MODIFICATIONS TO WORK SHOWN SHALL BE THE CARE AND RESPONSIBILITY OF THE PERMITTEE FROM THE CONSULTANT. THIS DRAWING IS THE EXCLUSIVE PROPERTY OF THE CONSULTANT AND CANNOT BE REPRODUCED, COPIED, OR LOANED WITHOUT PERMISSION OF THE CONSULTANT.



MCMURRAY NÉTB
440 SARGENTWAY TRAIL, FORT MCMURRAY, ALBERTA, T1H 6P2
ARCHITECT

mindful
ARCHITECTURE LTD

318 W. GILMAN RD., NORTH VANCOUVER, BC V7N 2W3 778.227.7567

5	2021, MAR 19	ISSUED FOR COORDINATION 05
4	2021, MAR 12	ISSUED FOR COORDINATION 04
3	2021, MAR 05	ISSUED FOR COORDINATION 03
2	2021, FEB 25	ISSUED FOR COORDINATION 02
1	2021, FEB 18	ISSUED FOR COORDINATION 01
NO	DATE	DESCRIPTION



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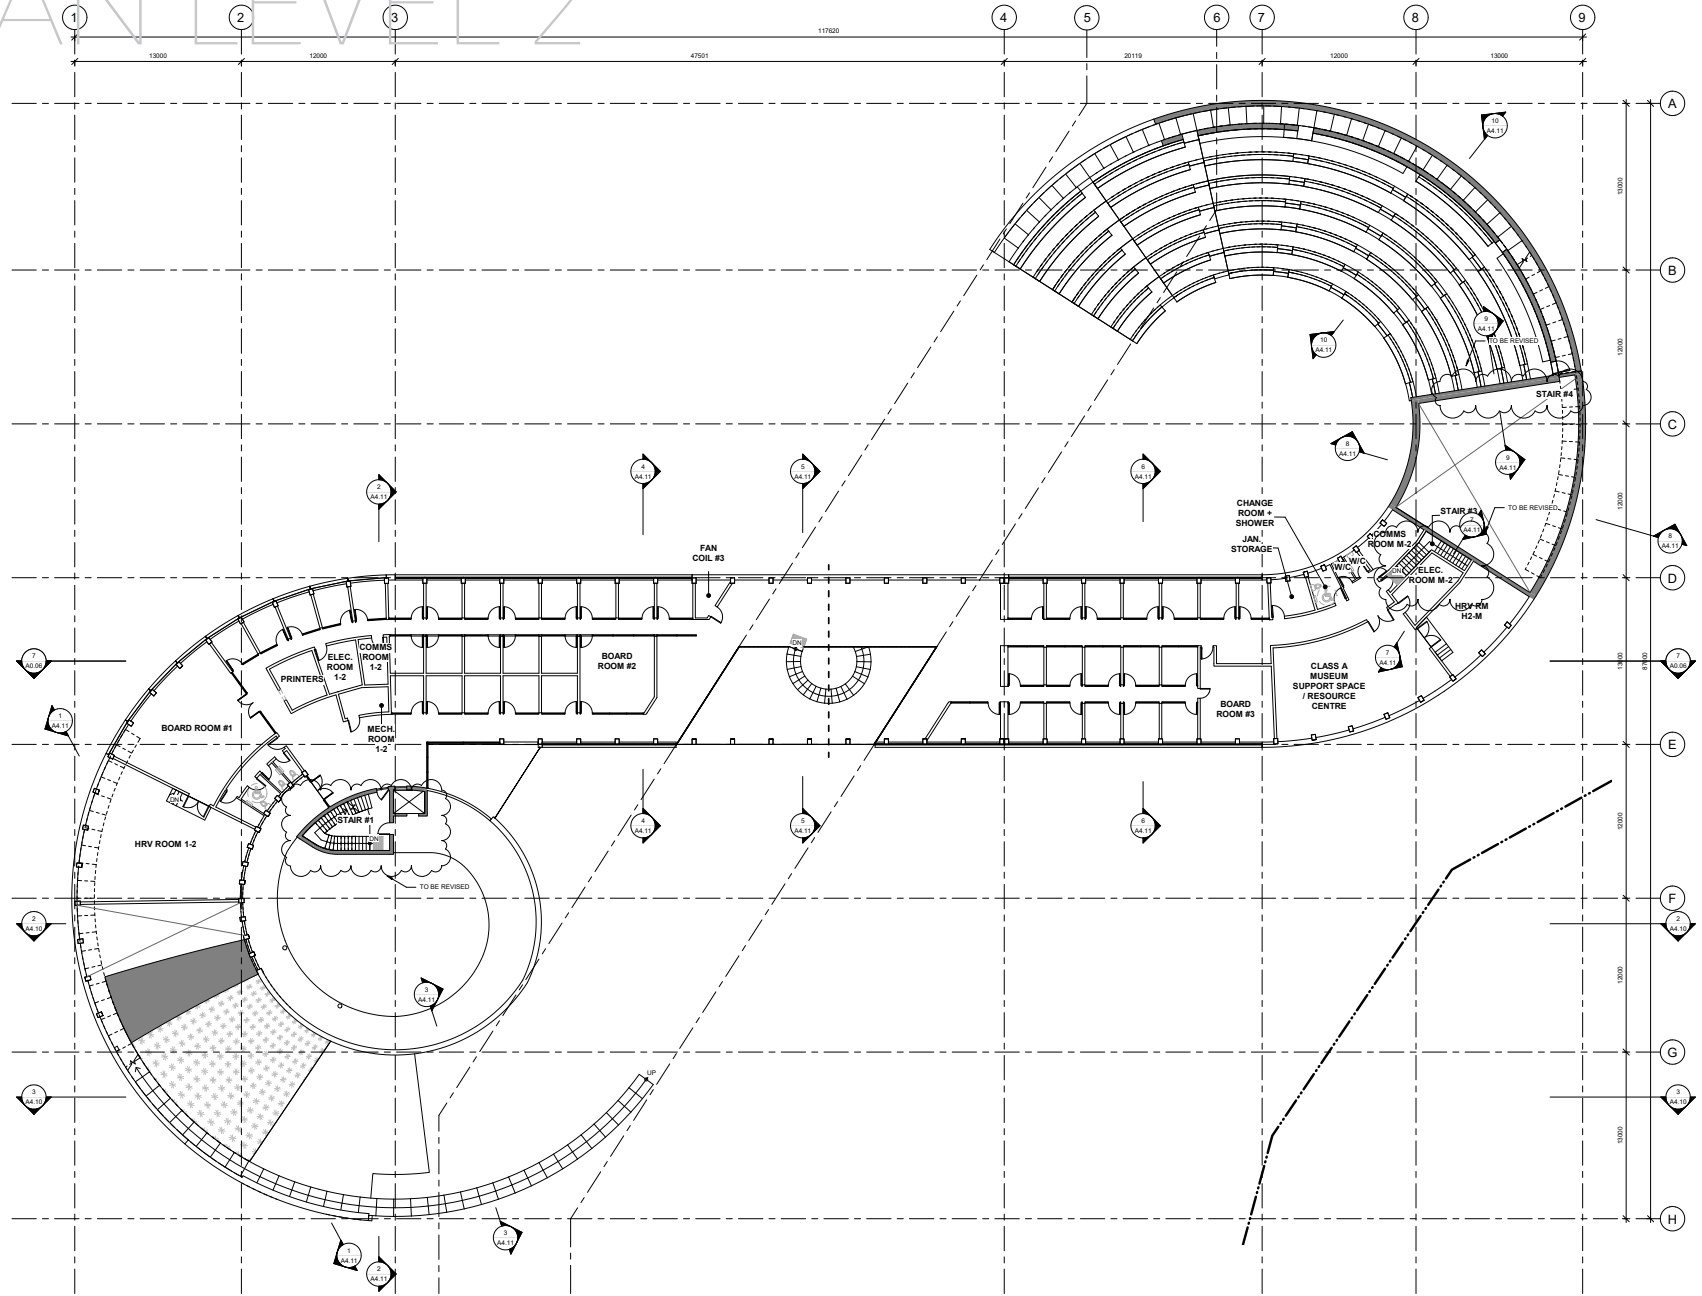
PROJECT:
McMURRAY METIS CULTURAL
CENTRE
MACDONALD ISLAND WAY,
FORT McMURRAY

DRAWING:
OVERALL PLAN - GROUND

PROJECT NO: T20074	SCALE: As indicated
START DATE: 2021, FEB 01	DRAWN BY: KF
FORMAT: 30" x 42"	CHECKED BY: TD/MMC


A2.02

PLAN LEVEL 2



1 OVERALL - SECOND FLOOR PLAN
A2.04 SCALE: 1:150
FLOOR AREA: 1683.59 m²

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18 W. GARDEN RD. NORTH WOODBINE, ONTARIO, M2H 1Y1

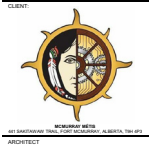11 2021 MAY 10 - ISSUED FOR COORDINATION TO
12 2021 MAY 10 - ISSUED FOR COORDINATION TO
13 2021 MAY 10 - ISSUED FOR COORDINATION TO
14 2021 FEB 10 - ISSUED FOR COORDINATION TO
15 2021 FEB 10 - ISSUED FOR COORDINATION TO

DATE DESCRIPTION
DRAWING PREPARED UNDER THE SUPERVISION
OF REGISTERED ARCHITECTURE (P)

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CONSTRUCTION

NORTH POINT: SEAL:




PROJECT:
McMURRAY METIS CULTURAL
CENTRE
MACDONALD ISLAND WAY,
FORT MCMURRAY

DRAWING:
OVERALL PLAN - SECOND
FLOOR

PROJECT NO: T20074 SCALE: 1:150
START DATE: 2021, FEB 01
FORNAT: 30" x 42" CHECKED BY: TDMMC
SHEET NUMBER:

A2.04

TERRACE

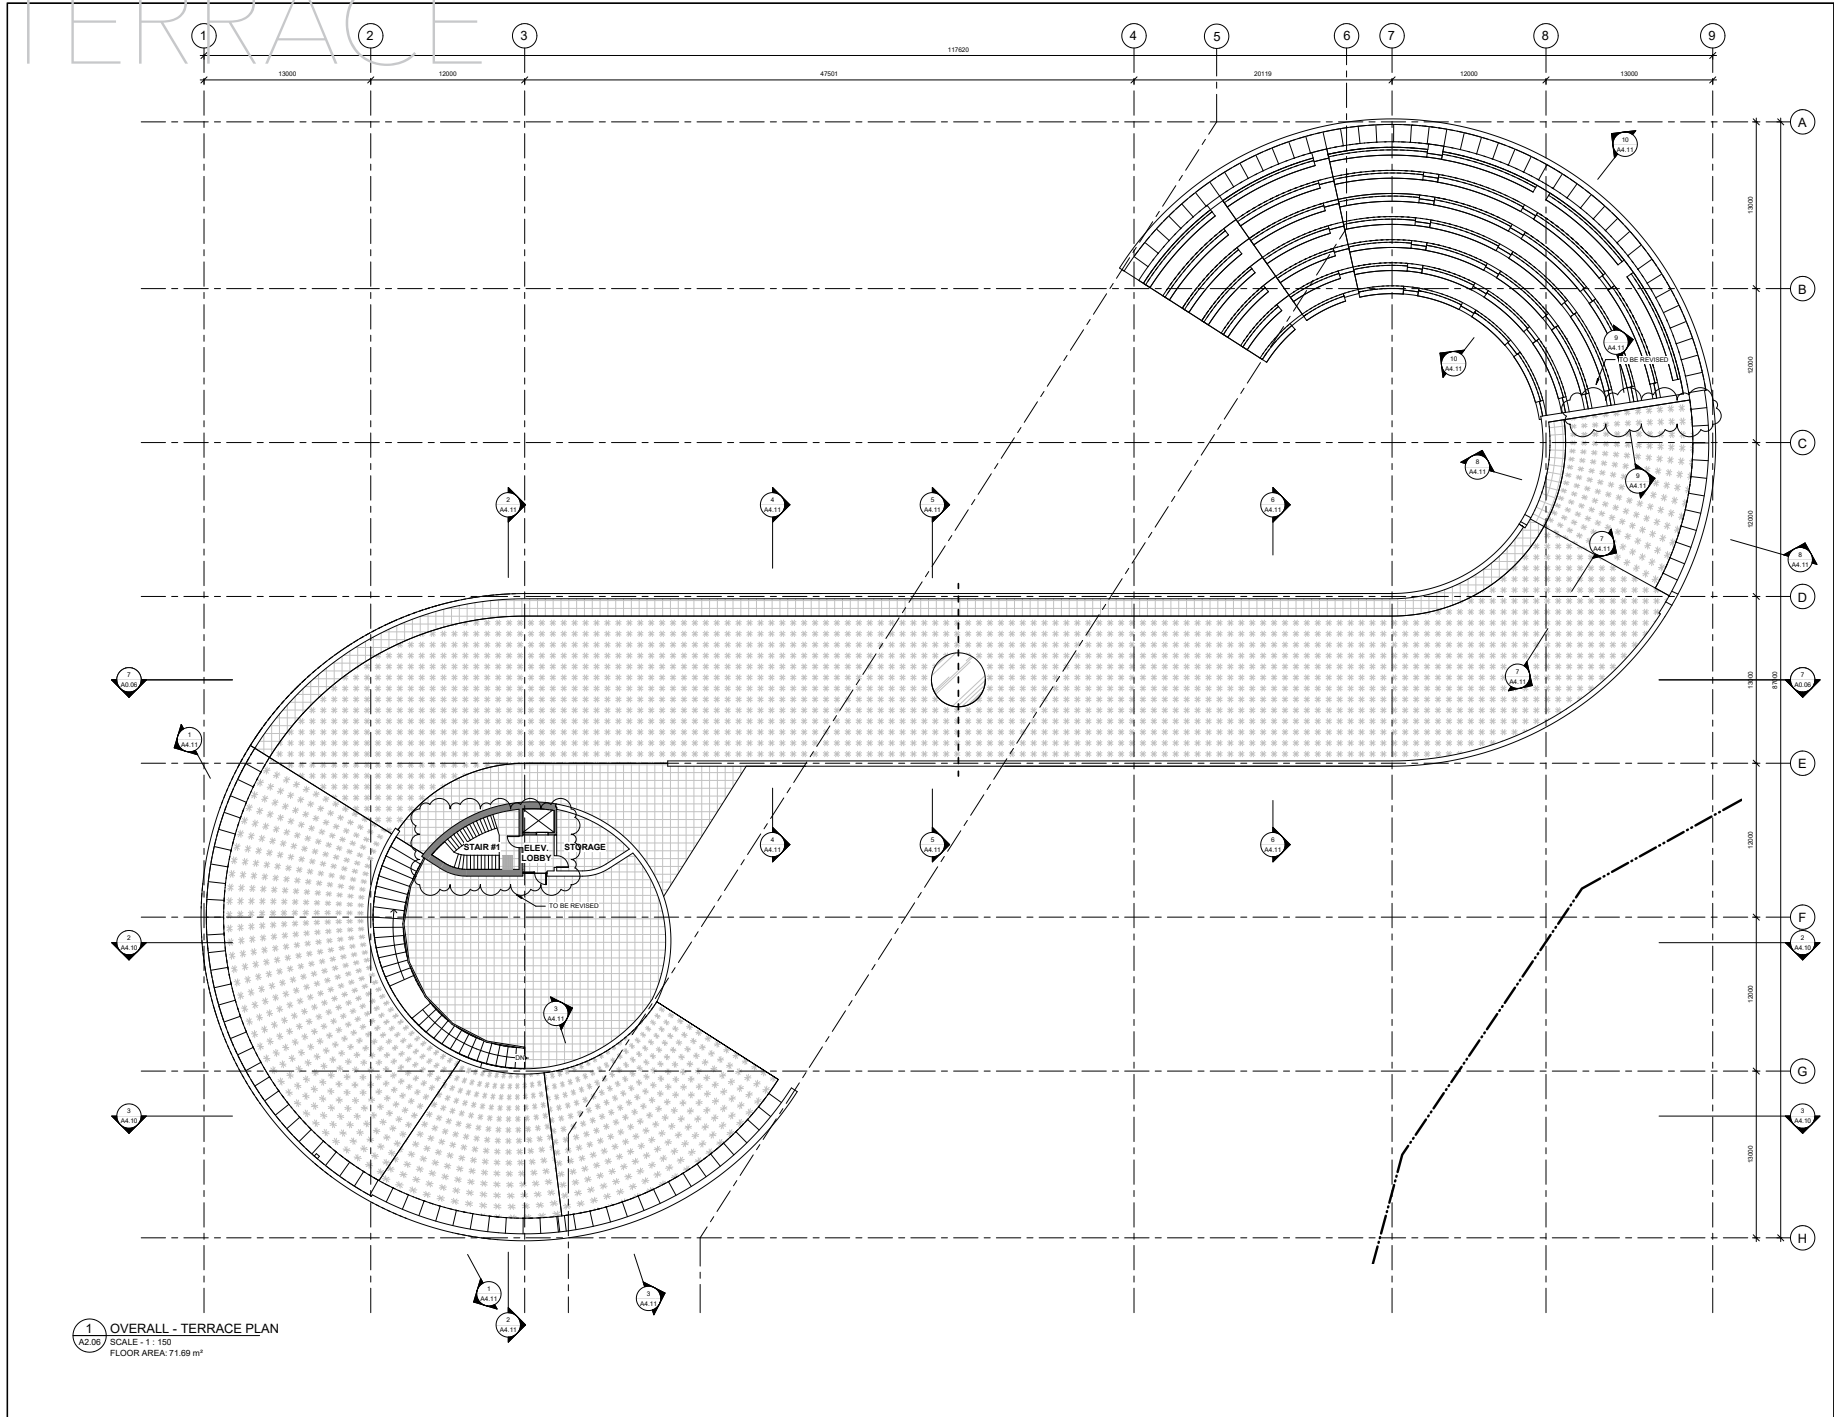

THIS DRAWING MUST NOT BE SCALED. THE GENERAL CONTRACTOR SHALL VERIFY ALL DIMENSIONS, DATUMS AND LEVELS PRIOR TO COMMENCEMENT OF WORK. ALL DIMENSIONS AND LEVELS MUST BE REPORTED IMMEDIATELY TO THE CONSULTANT. THIS DRAWING IS TO BE USED IN CONSTRUCTION WITH ALL OTHER DRAWINGS AND SPECIFICATIONS. DIMENSIONS AND NOTATIONS TO BE SHOWN SHALL NOT BE CHANGED WITHOUT THE WRITTEN PERMISSION FROM THE CONSULTANT. THIS DRAWING IS THE EXCLUSIVE PROPERTY OF THE CONSULTANT AND CANNOT BE REPRODUCED, COPIED, OR LOANED WITHOUT PERMISSION OF THE CONSULTANT.



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ARCHITECTURE LTD

111 GORDON ST. 2ND FLOOR, ADELAIDE, SA 5000

1. 2021 MAR 10 - ISSUED FOR COORDINATION TO
2. 2021 MAR 10 - ISSUED FOR COORDINATION TO
3. 2021 MAR 10 - ISSUED FOR COORDINATION TO
4. 2021 FEB 10 - ISSUED FOR COORDINATION TO
5. 2021 FEB 10 - ISSUED FOR COORDINATION TO

DATE: 2021 FEB 10
DRAWN BY: [Signature]

DESIGNED PREPARED UNDER THE SUPERVISION OF REGISTERED ARCHITECTURE BY
PARALLEL
ARCHITECTS PTY LTD
111 GORDON ST. 2ND FLOOR, ADELAIDE, SA 5000

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NORTH POINT: SEAL:




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MCMURRAY METIS CULTURAL CENTRE
MACDONALD ISLAND WAY,
FORT MCMURRAY

DRAWING:
OVERALL PLAN - TERRACE


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SCALE: 1:150
DRAWN BY: KF
CHECKED BY: TDM/MC

A2.06


SOLAR POTENTIAL

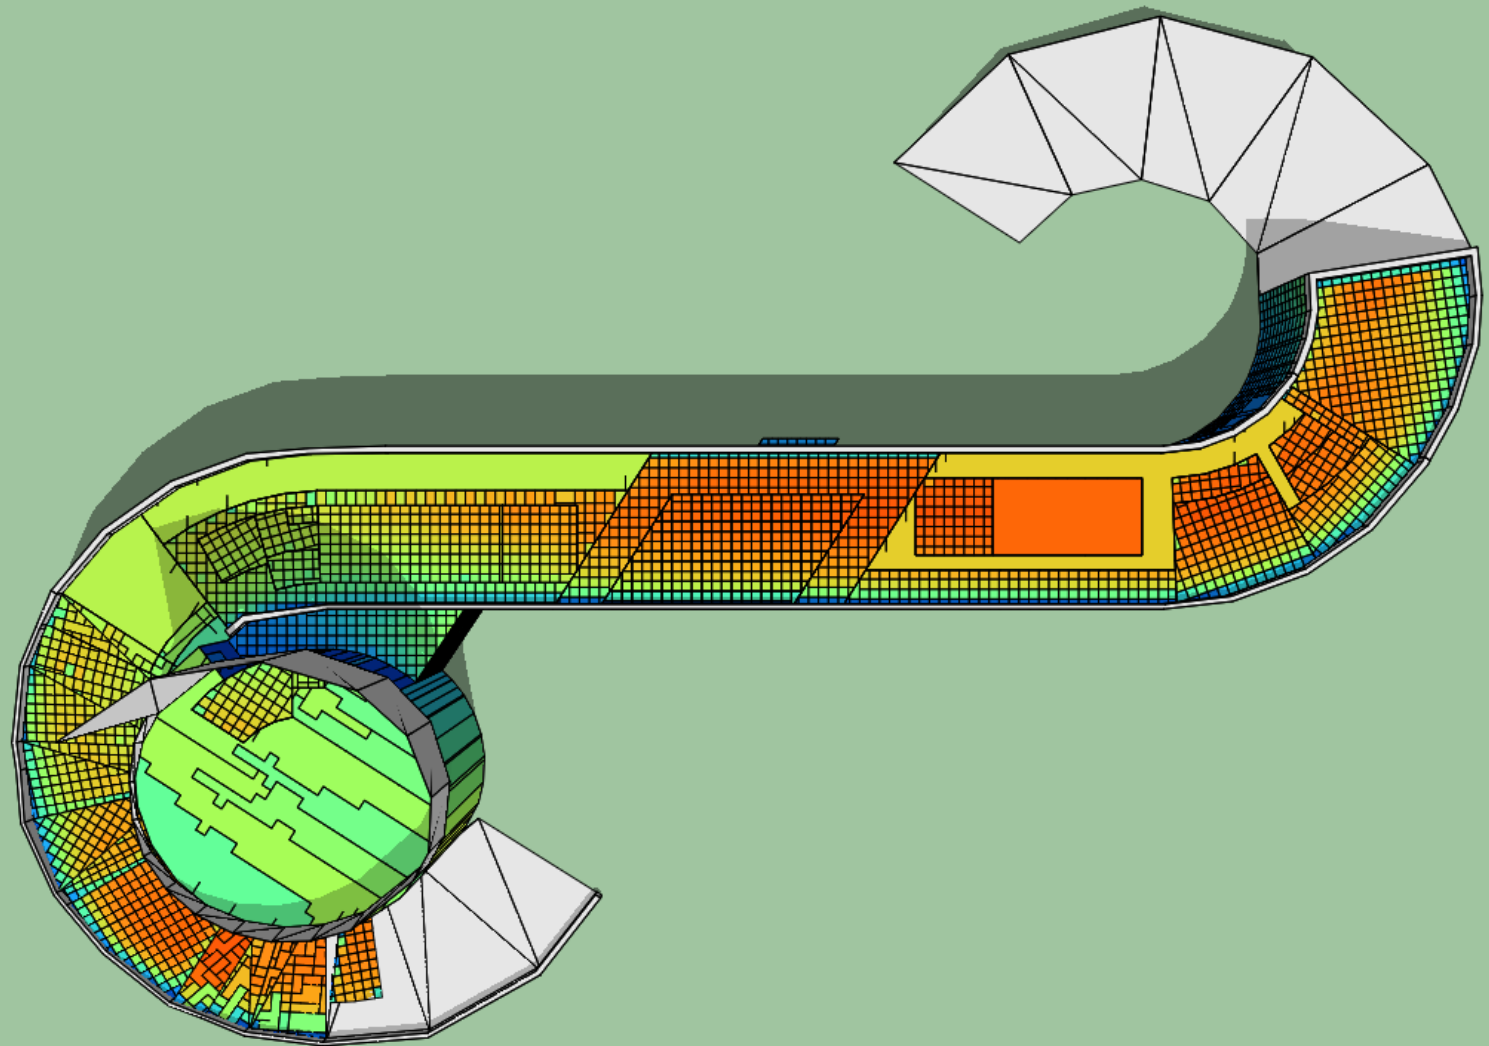

01/Jan - 00:00 to 31/Dec - 23:00
Hours

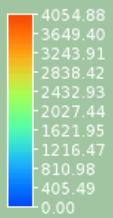


SOLAR PANELS

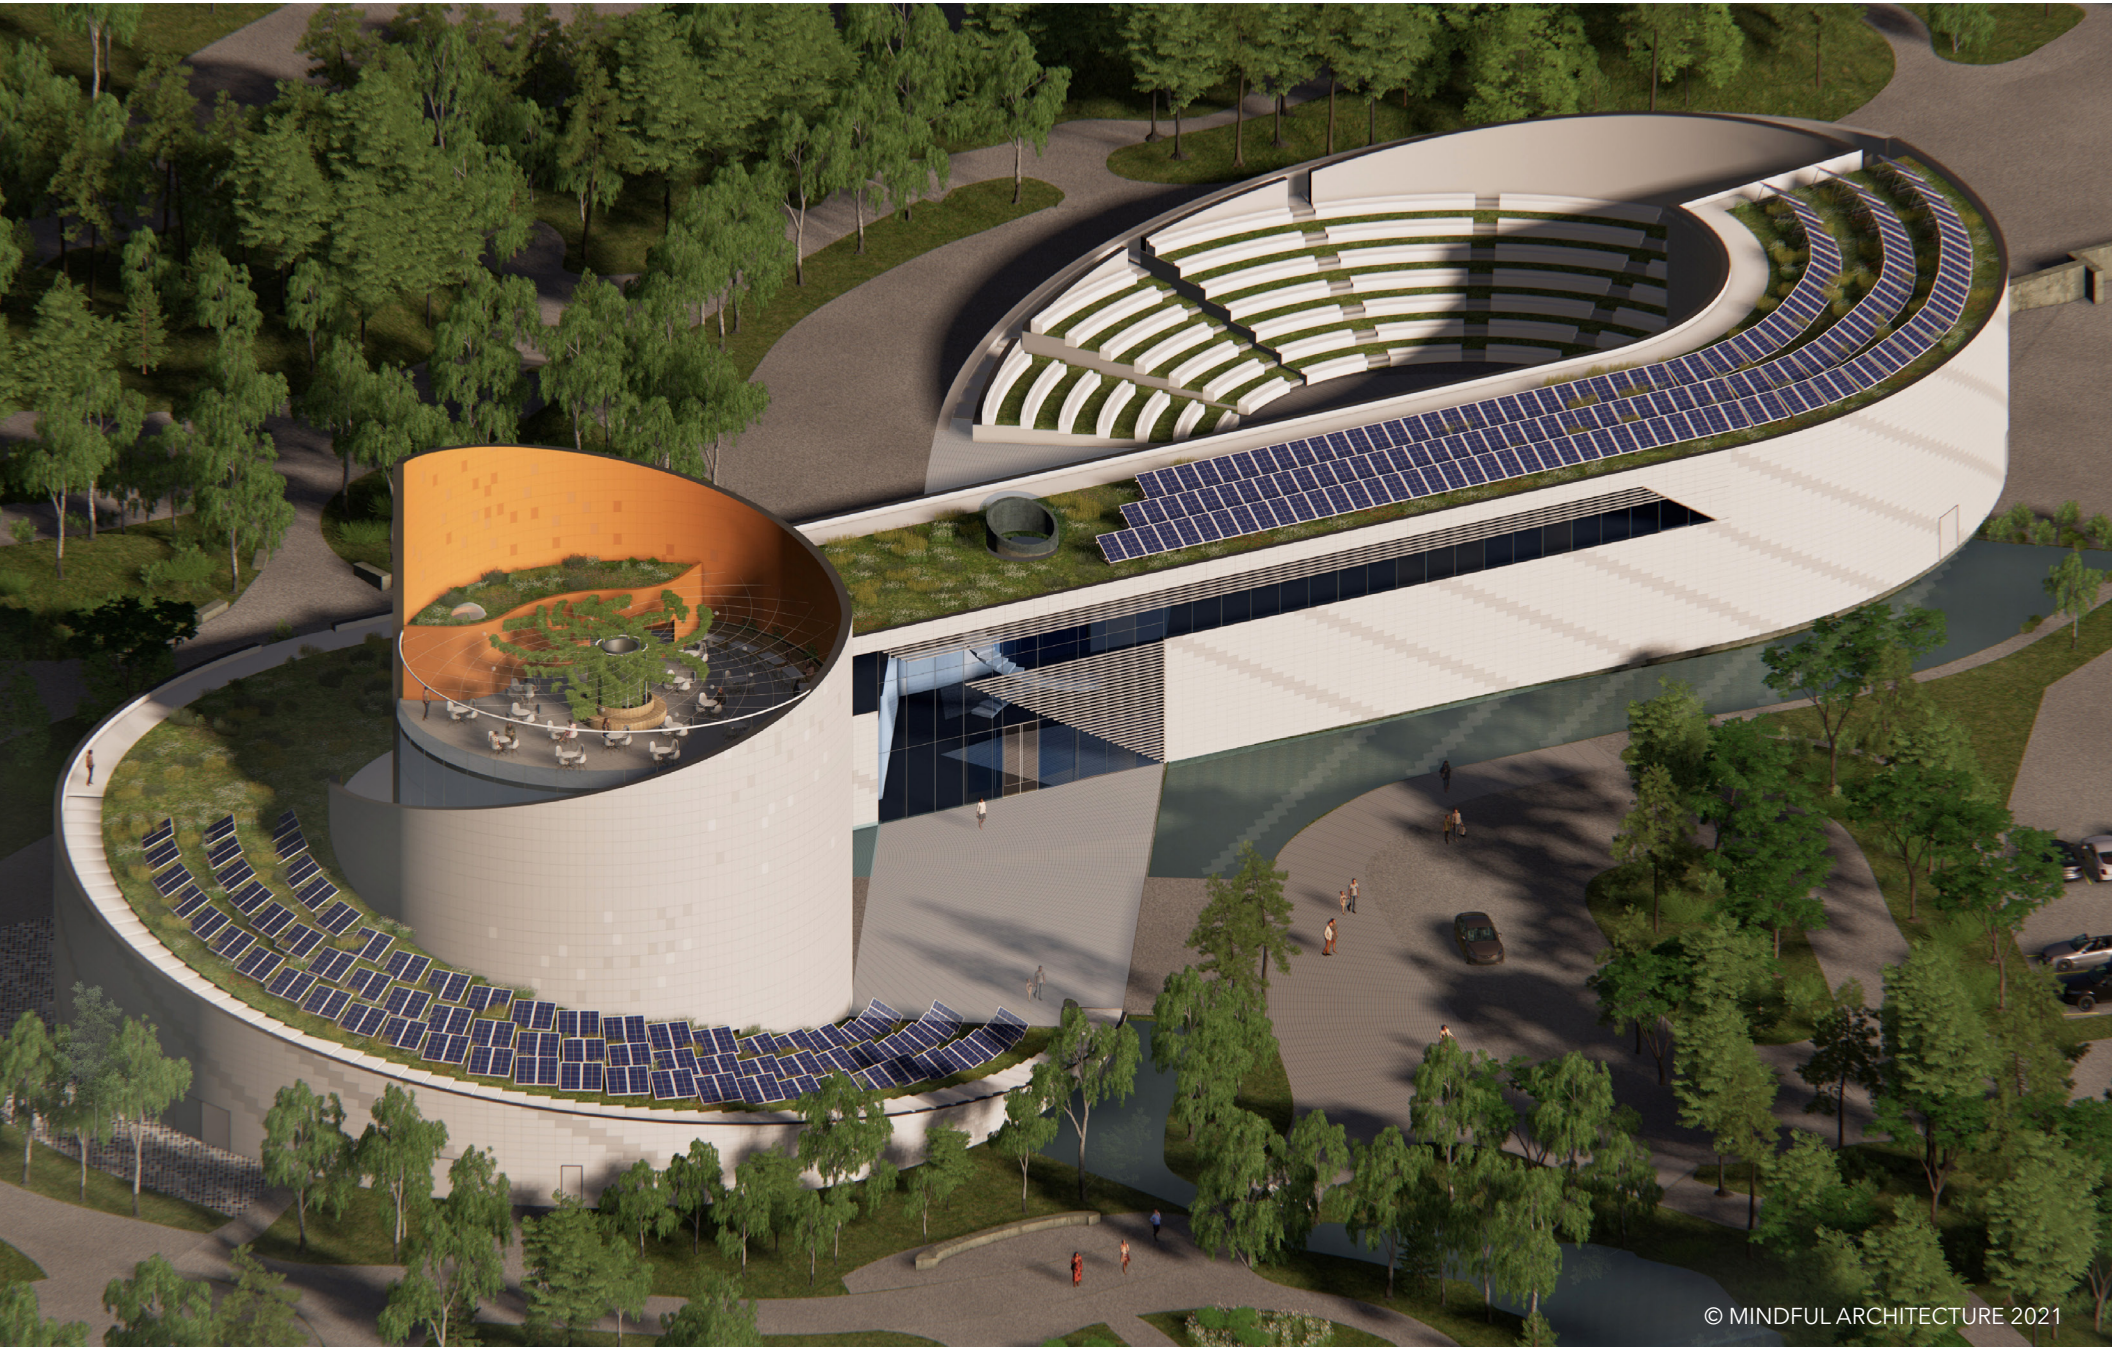



ASSEMBLY

ZINCO GREEN ROOF ASSEMBLY

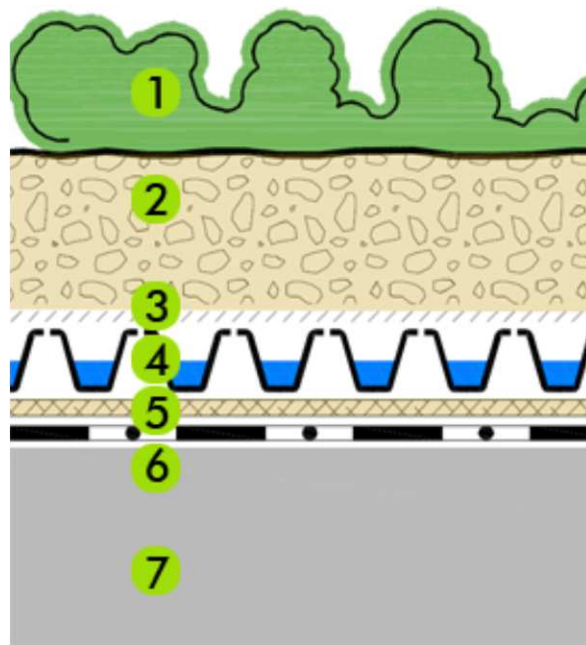

1. Plant Material (Sedum + Uprights)
2. Growing Medium ZinCoblend E
Depth 100-120 mm.
3. ZinCo Filter Sheet SF
4. ZinCo Floradrain® FD25-E
5. Protection mat ZinCo SSM45
6. ZinCo Root Barrier WSF40
7. Roof Construction with
Waterproofing Membrane

INSULATION



GREEN ROOF



TRADITIONAL ROOF

British Columbia Institute of Technology

FIRE PREVENTION



THERMAL COMFORT



THREE HEATING SOURCES

PASSIVE SYSTEMS


ACTIVE SYSTEMS

BIOMASS BOILER


PASSIVE SYSTEMS ORIENTATION




PASSIVE SYSTEMS ATRIUM

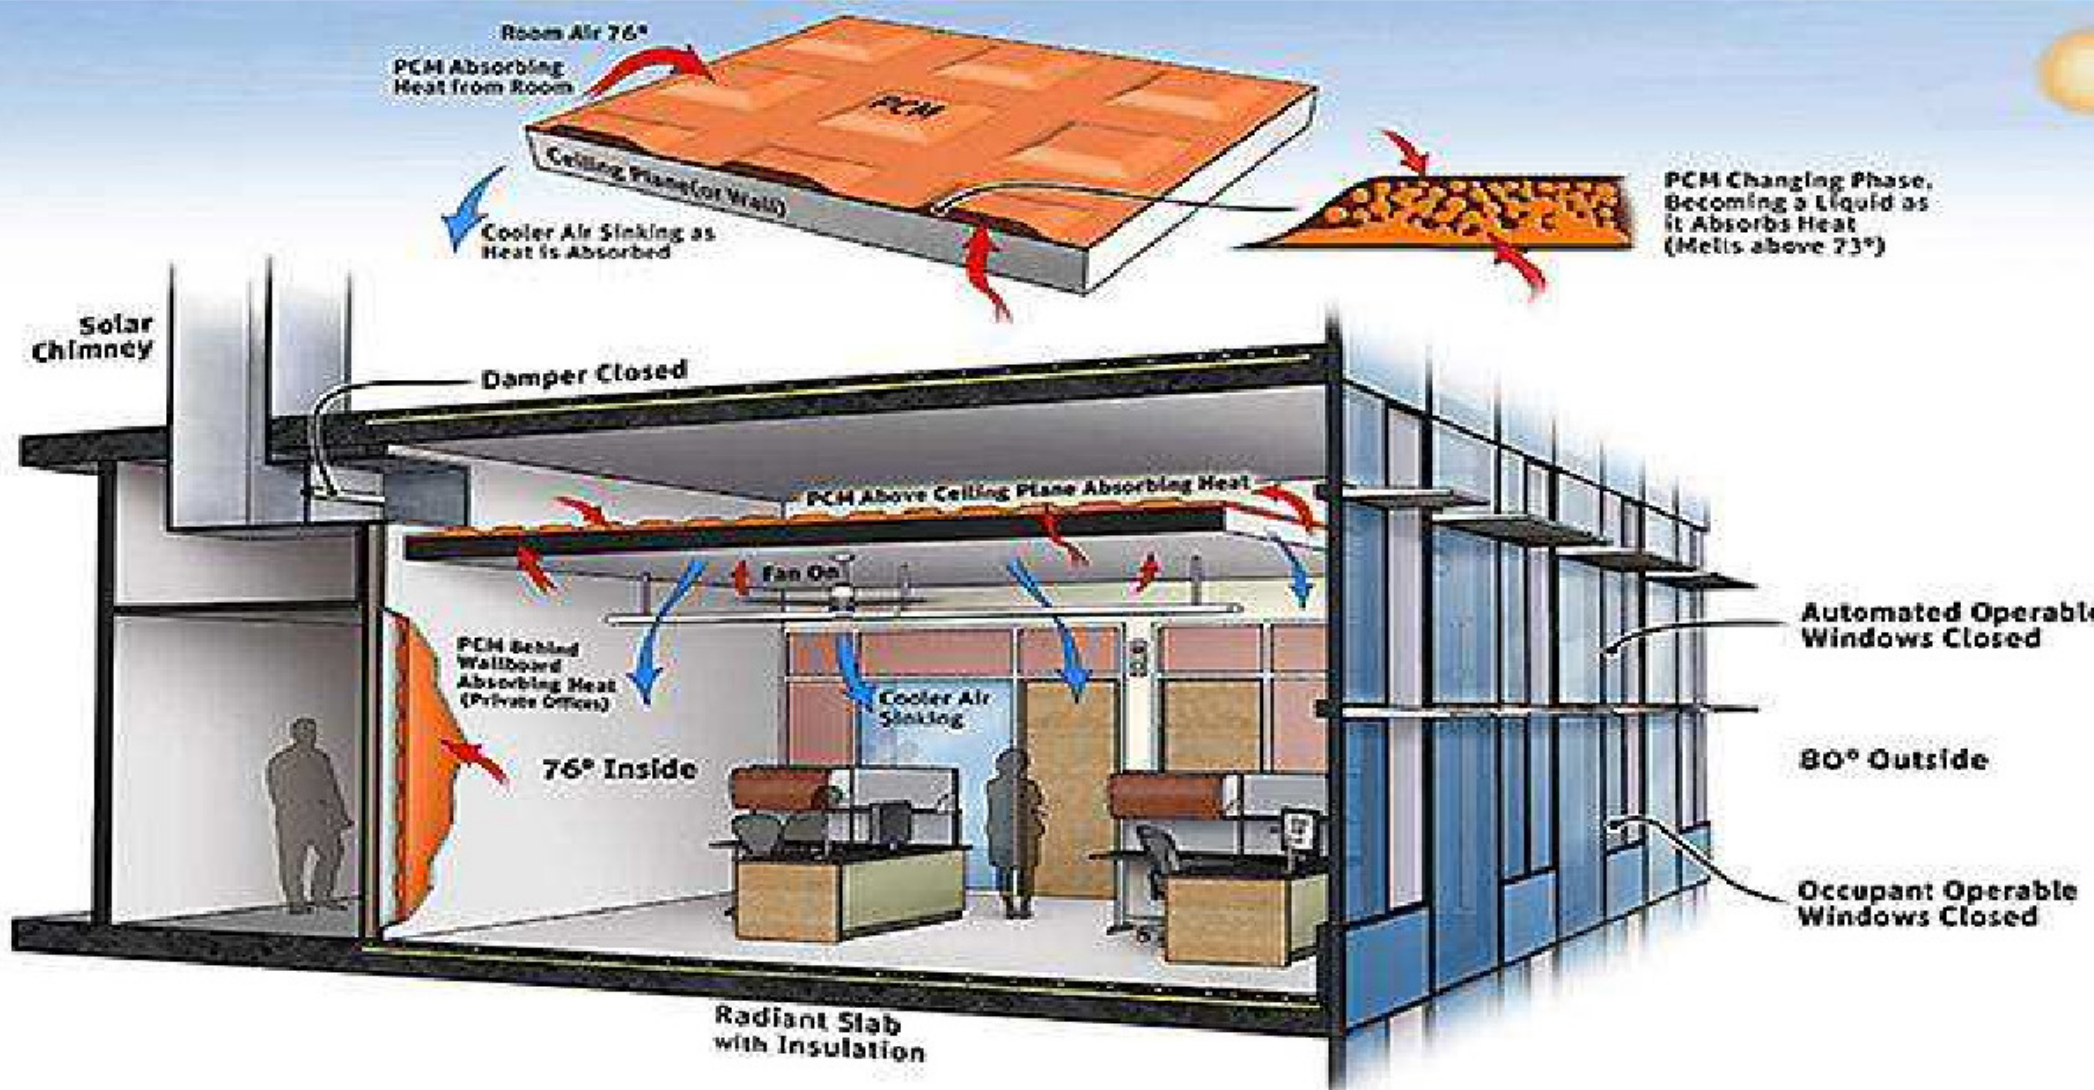


PASSIVE SYSTEMS EARTH TUBES

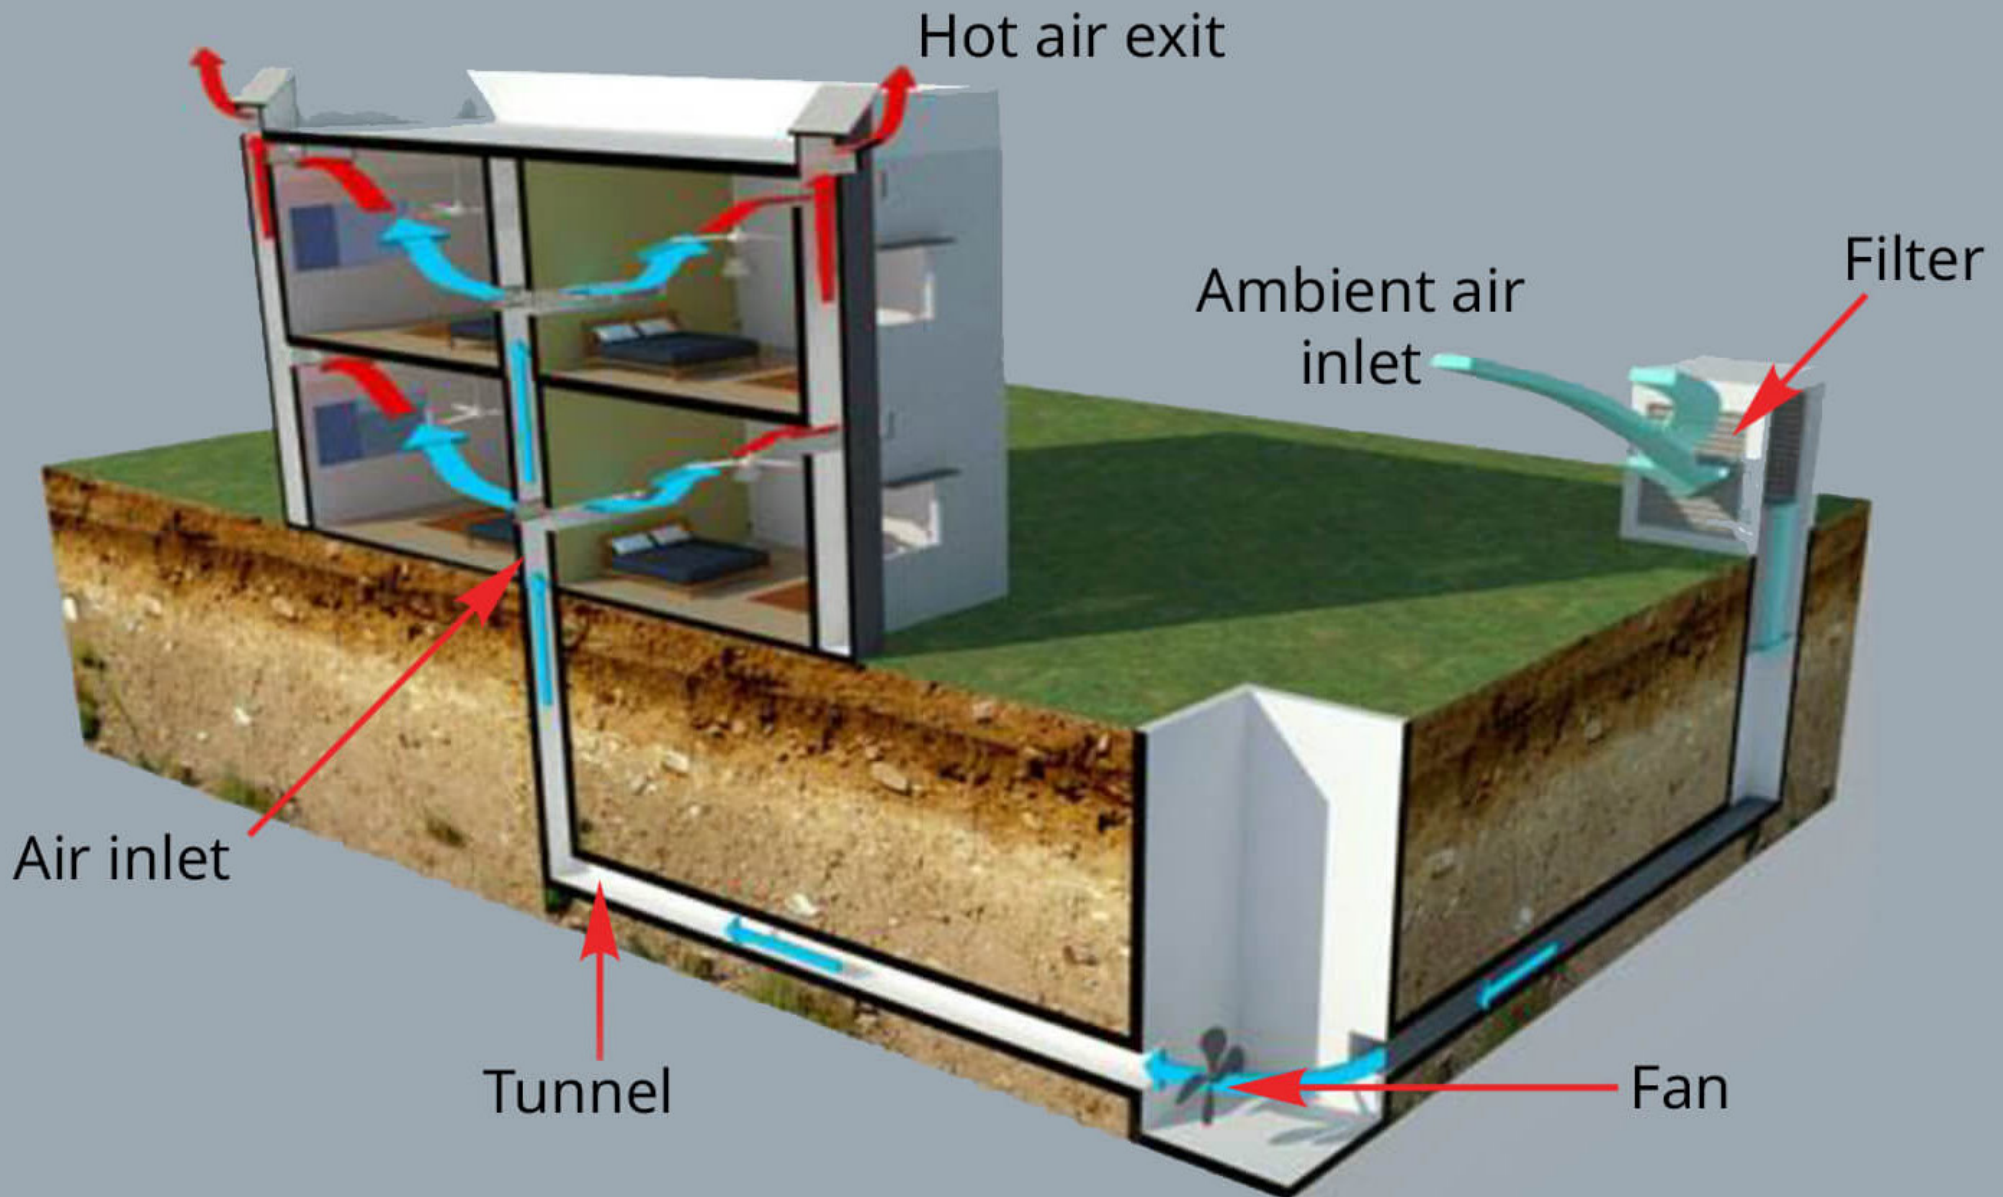


ACTIVE SYSTEMS HRV

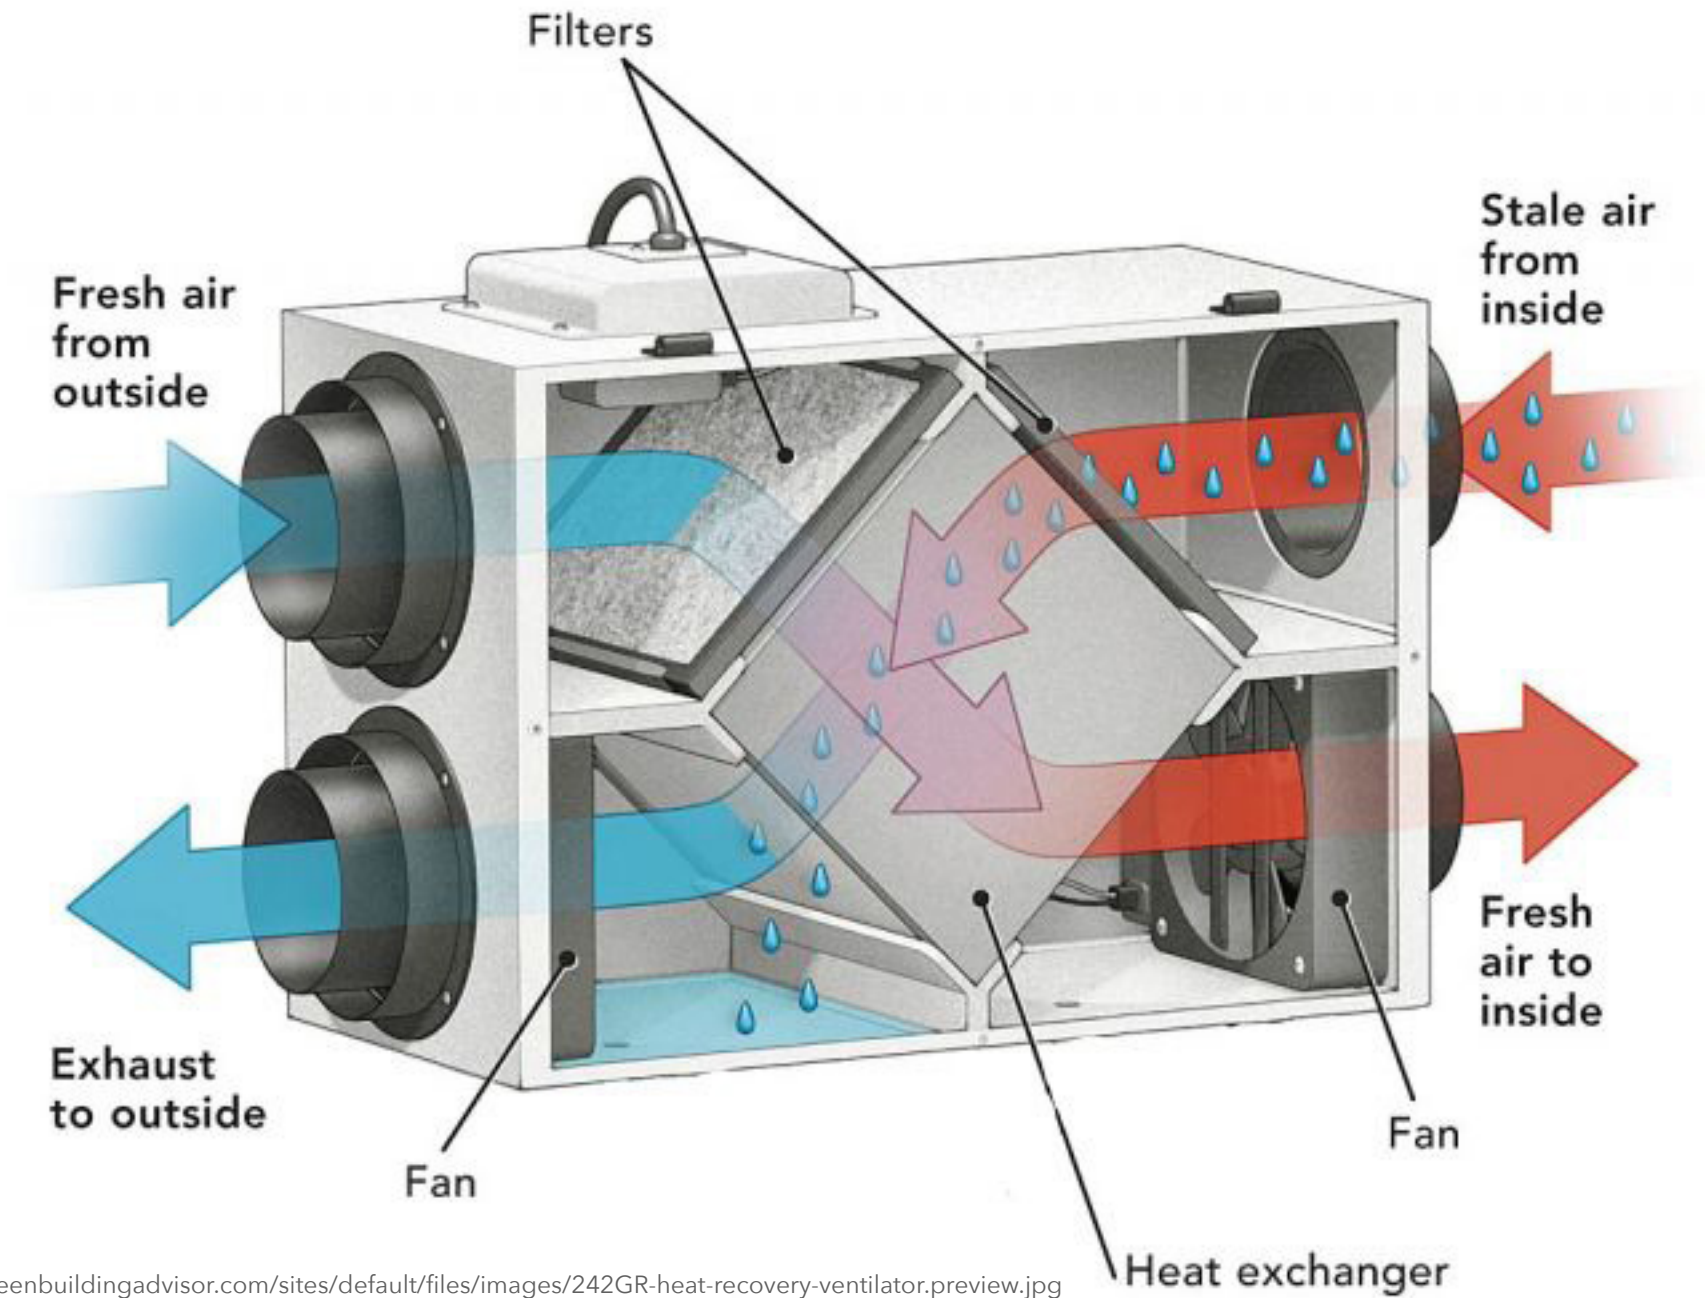


ACTIVE SYSTEMS HEAT PUMPS

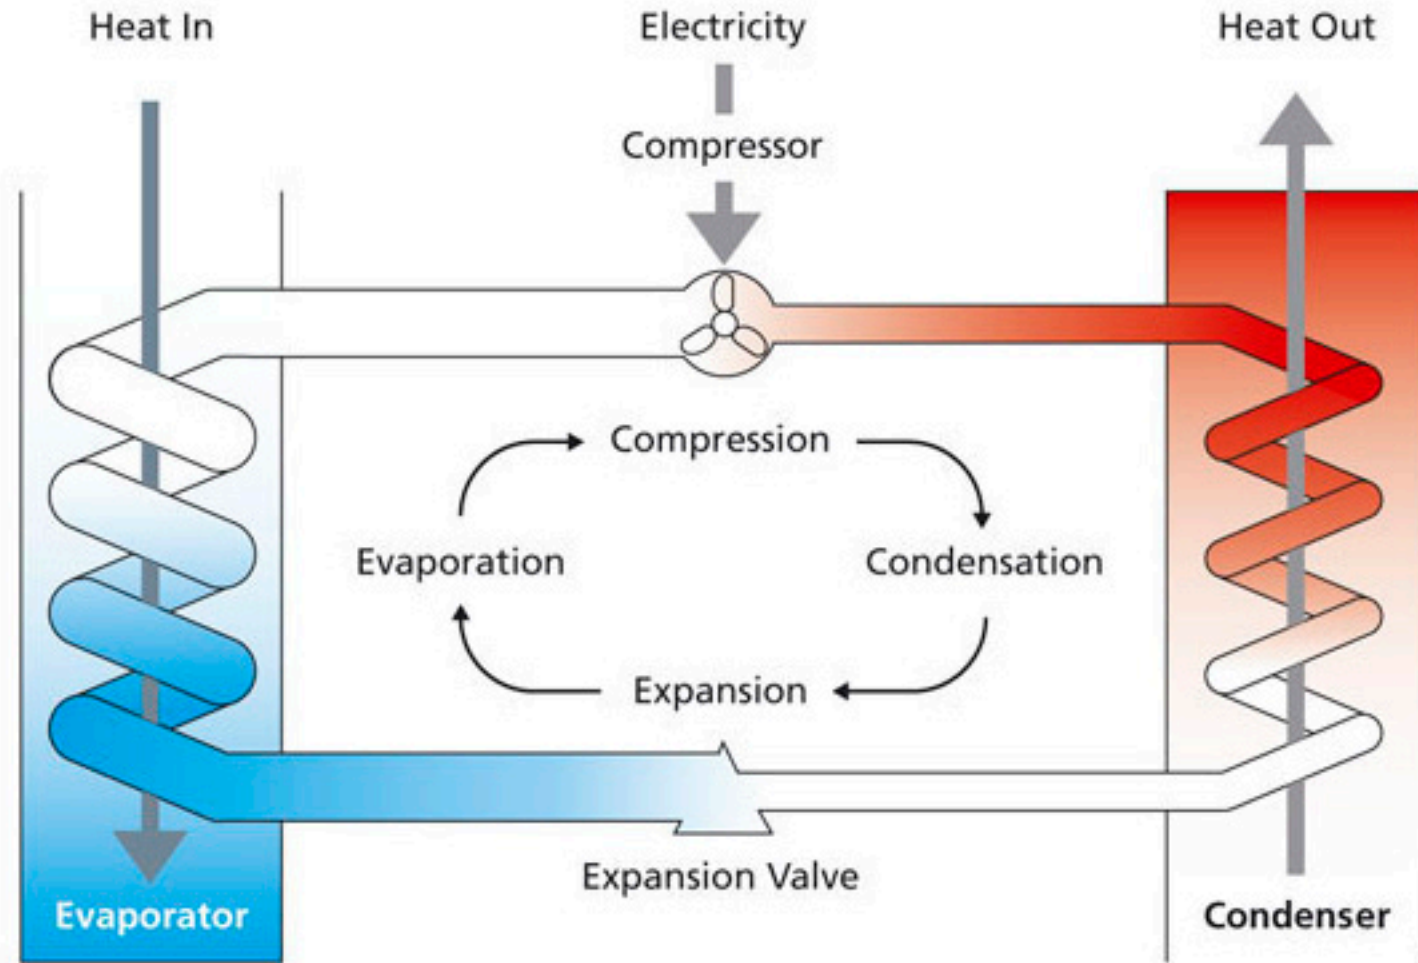

ACTIVE SYSTEMS SEWER HEAT RECOVERY

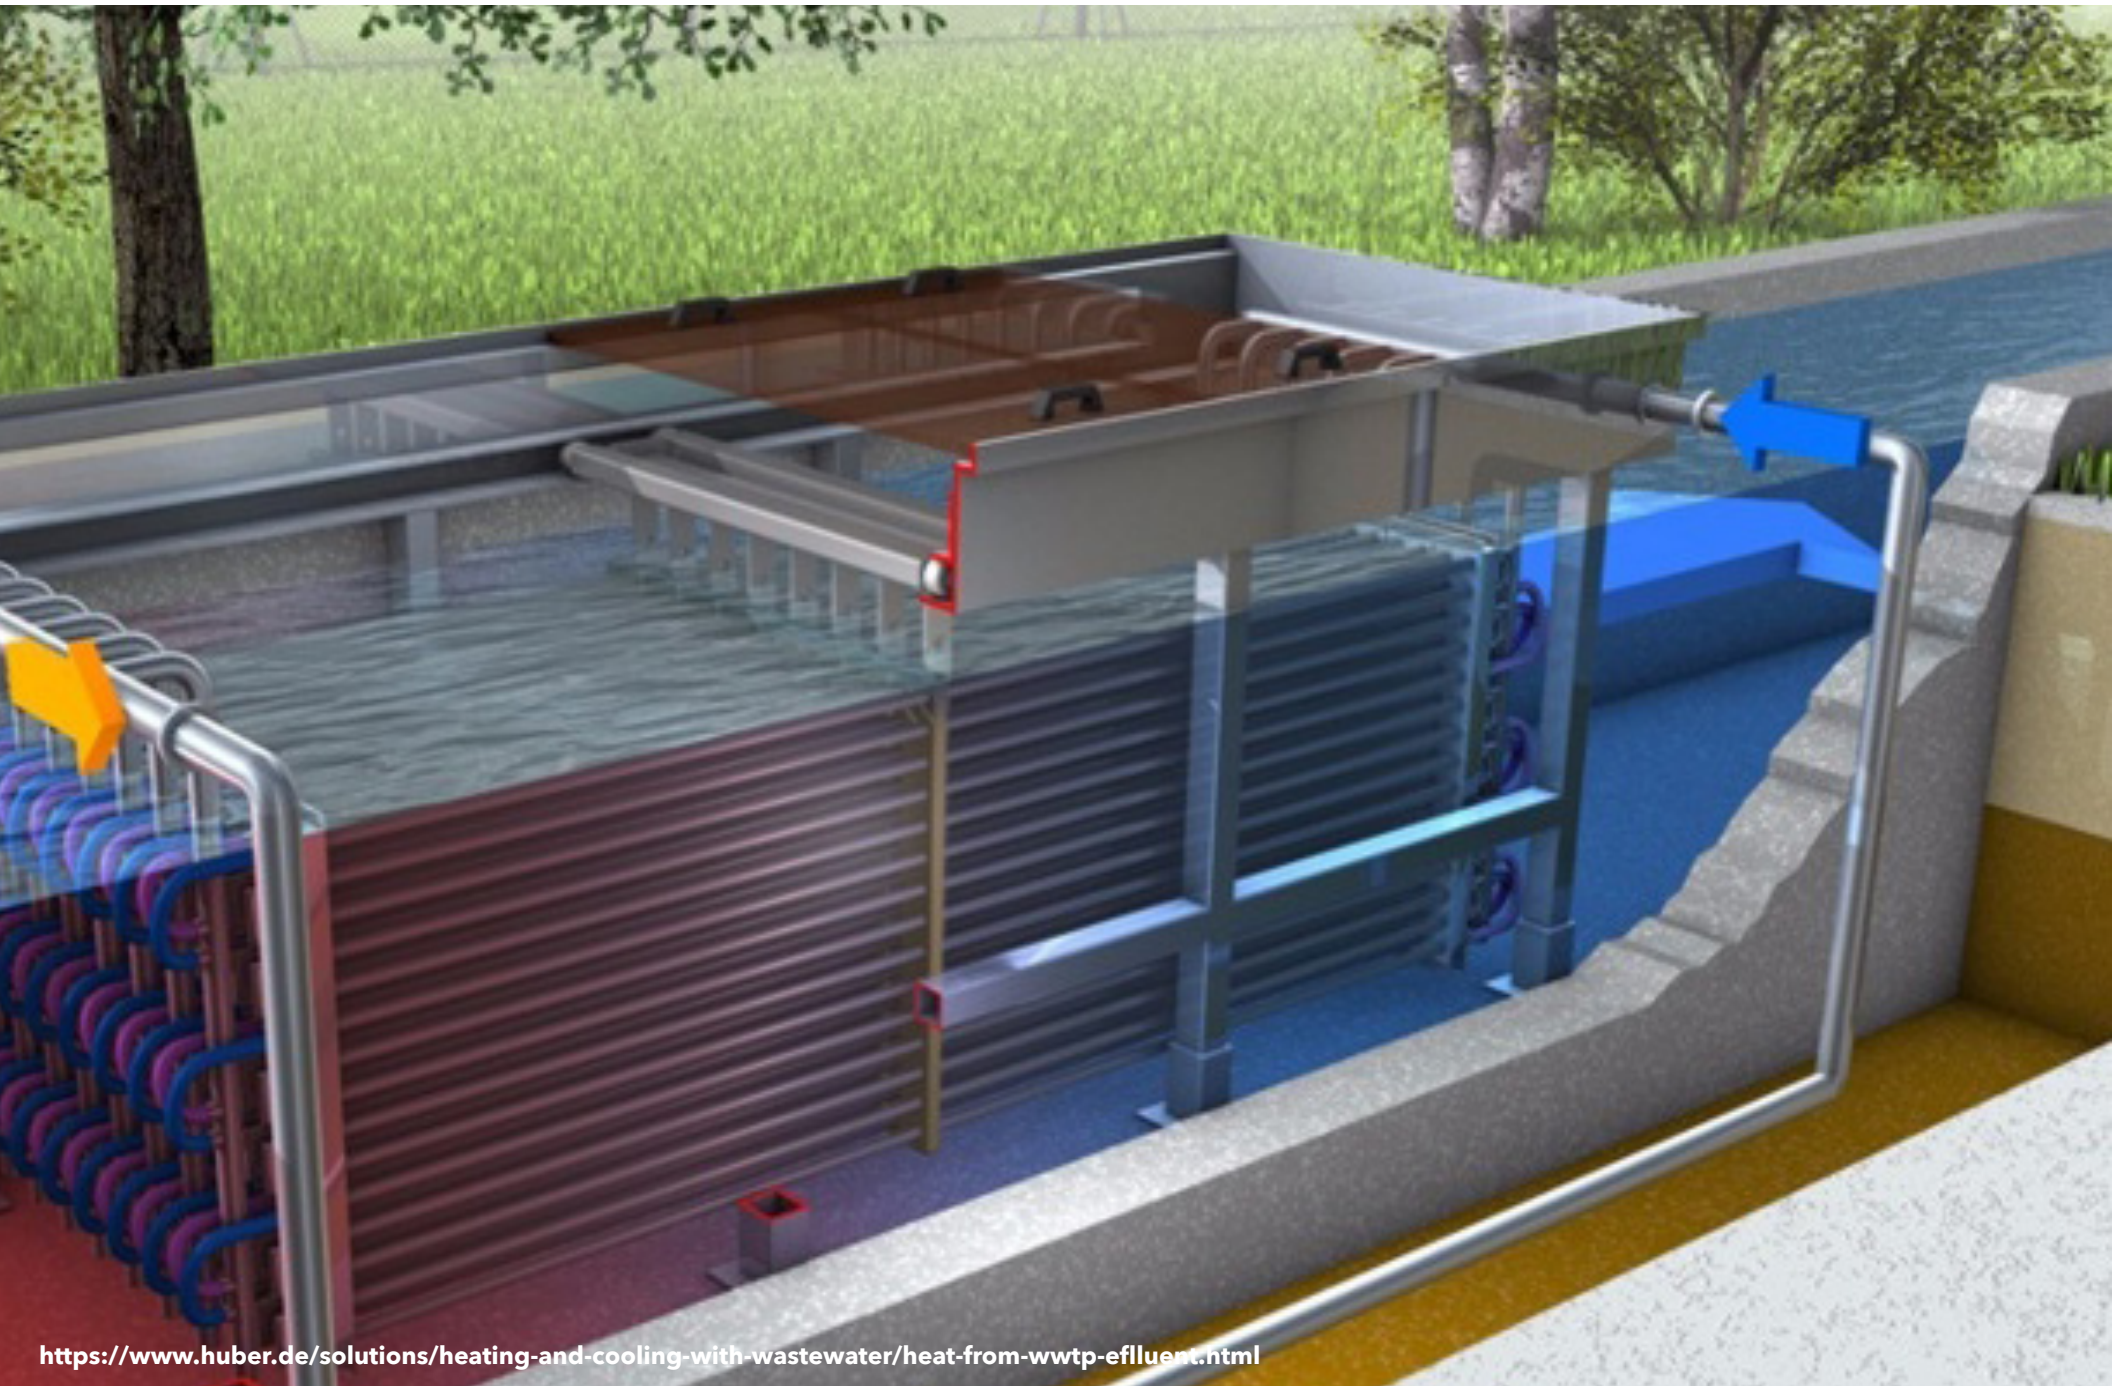

ACTIVE SYSTEMS BIOMASS BOILER

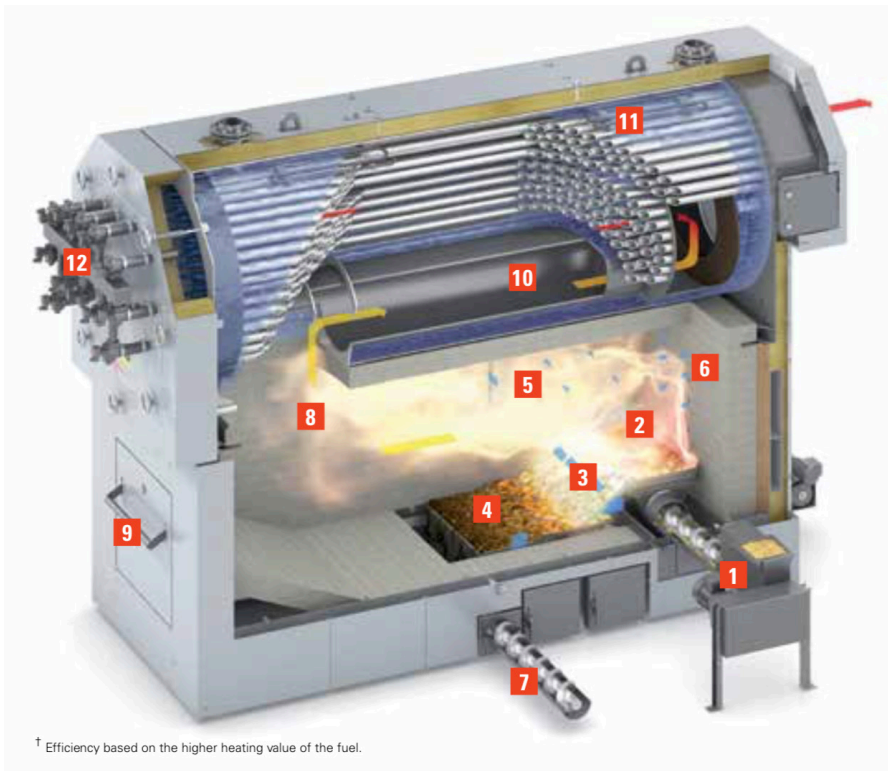

- 1 Infeed auger (with light barrier)
- 2 Burner trough with internal grate
- 3 Sloped grate
- 4 Moving grate
- 5 Secondary air flow
- 6 Igniter
- 7 Deashing system
- 8 High-temperature burnout zone
- 9 Combustion chamber door
- 10 Triple-pass heat exchanger
- 11 Safety heat exchanger
- 12 Pneumatic cleaning system



Portable boiler enclosure
(pellet silo field supplied)

BIOMASS REQUIREMENTS


200 tonnes of biomass per year (5 - 6 trucks/year)


Log storage for about 6 months to dry

A Chipper



BIOMASS BOILER

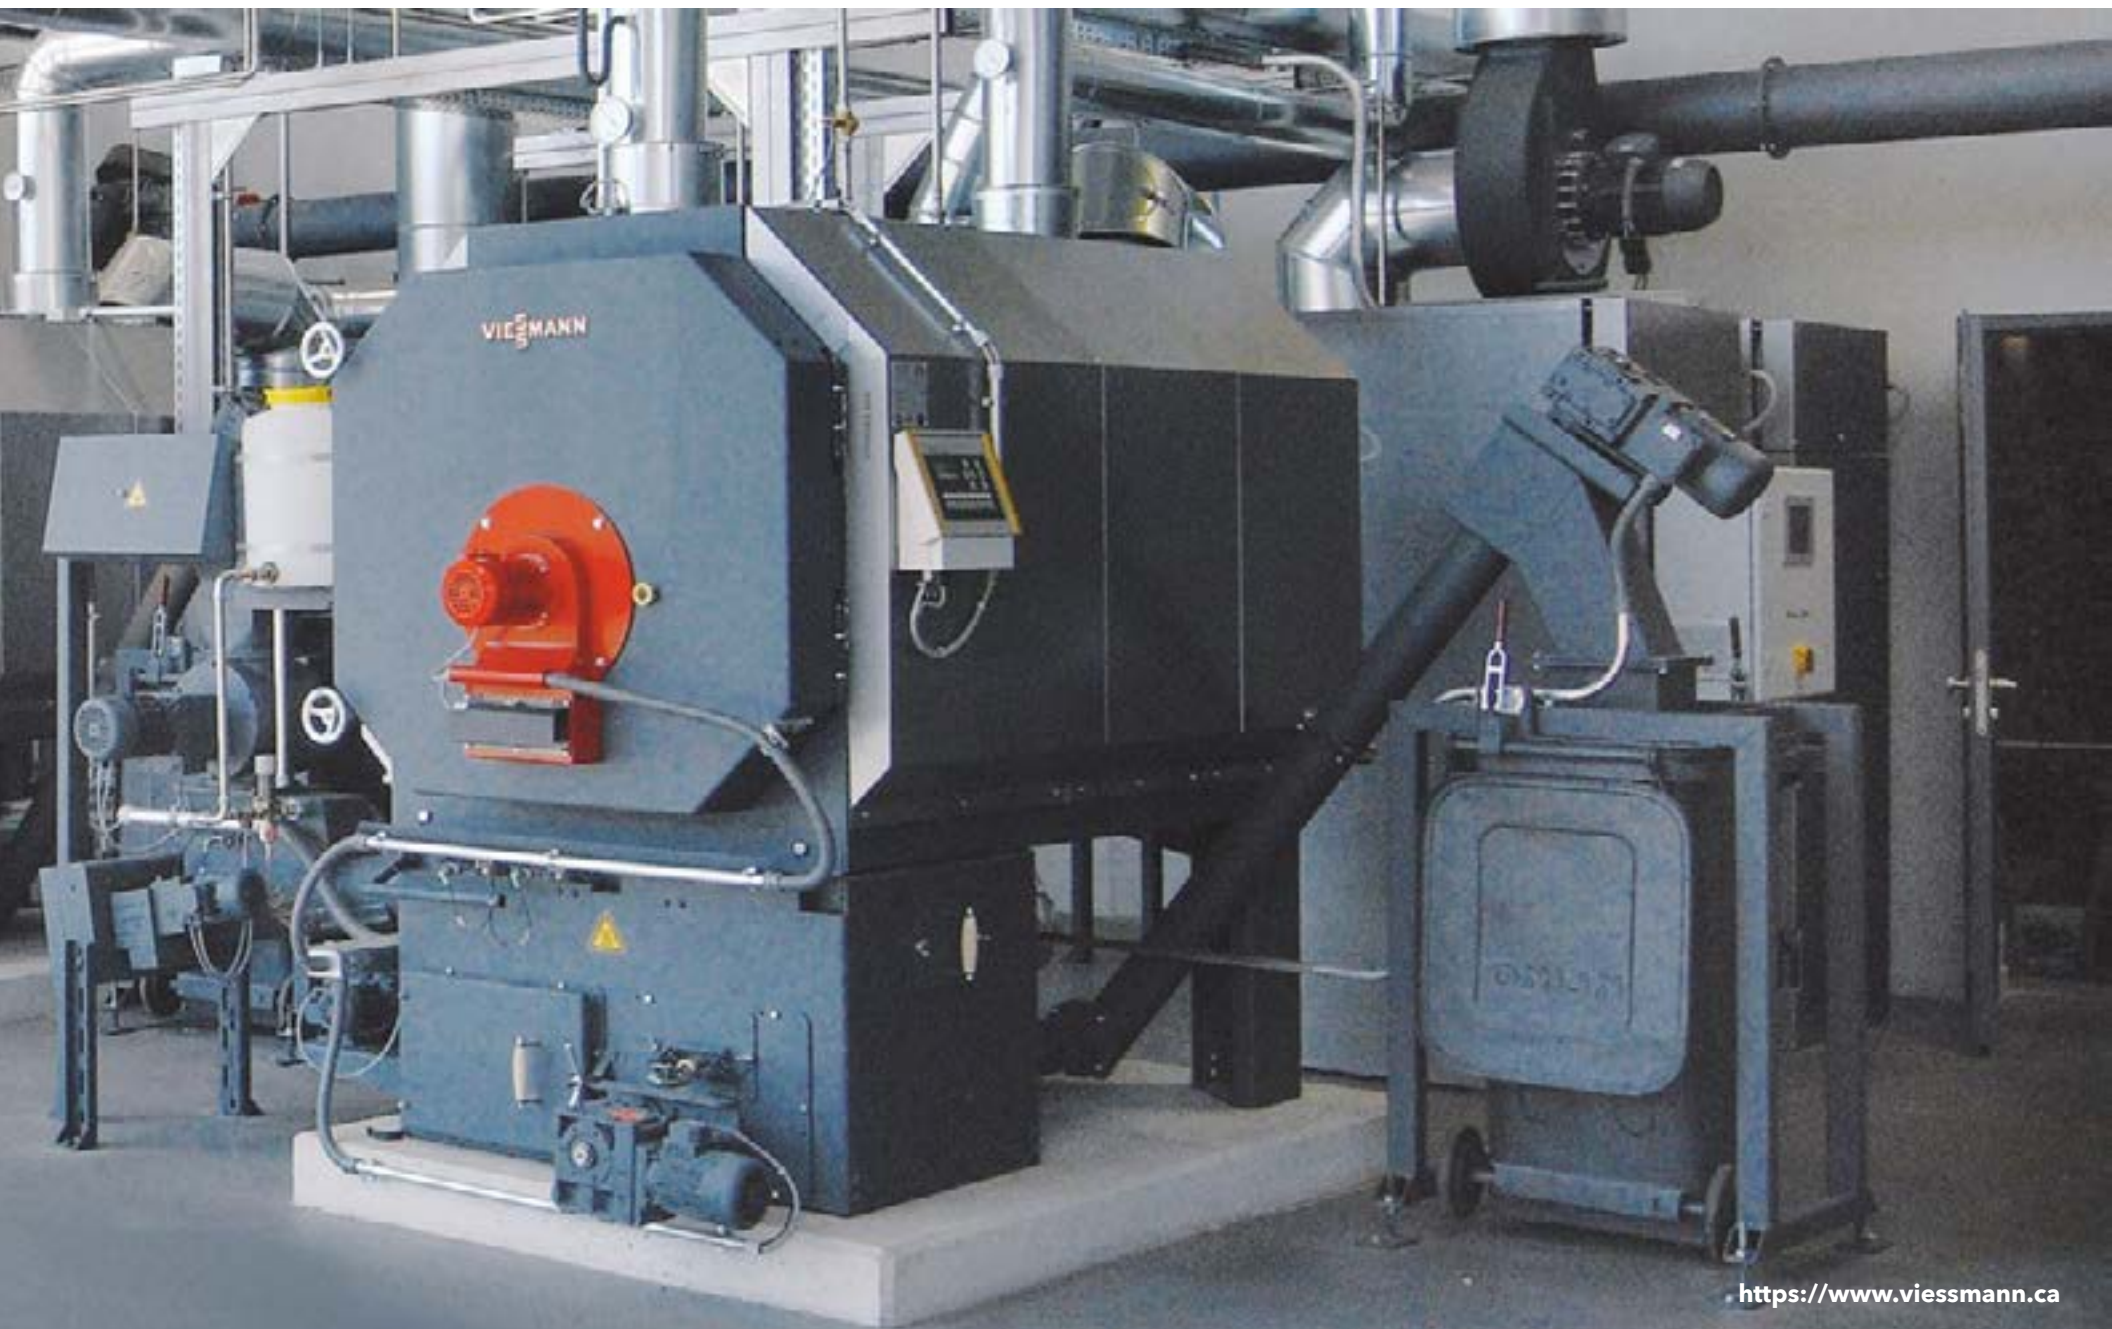

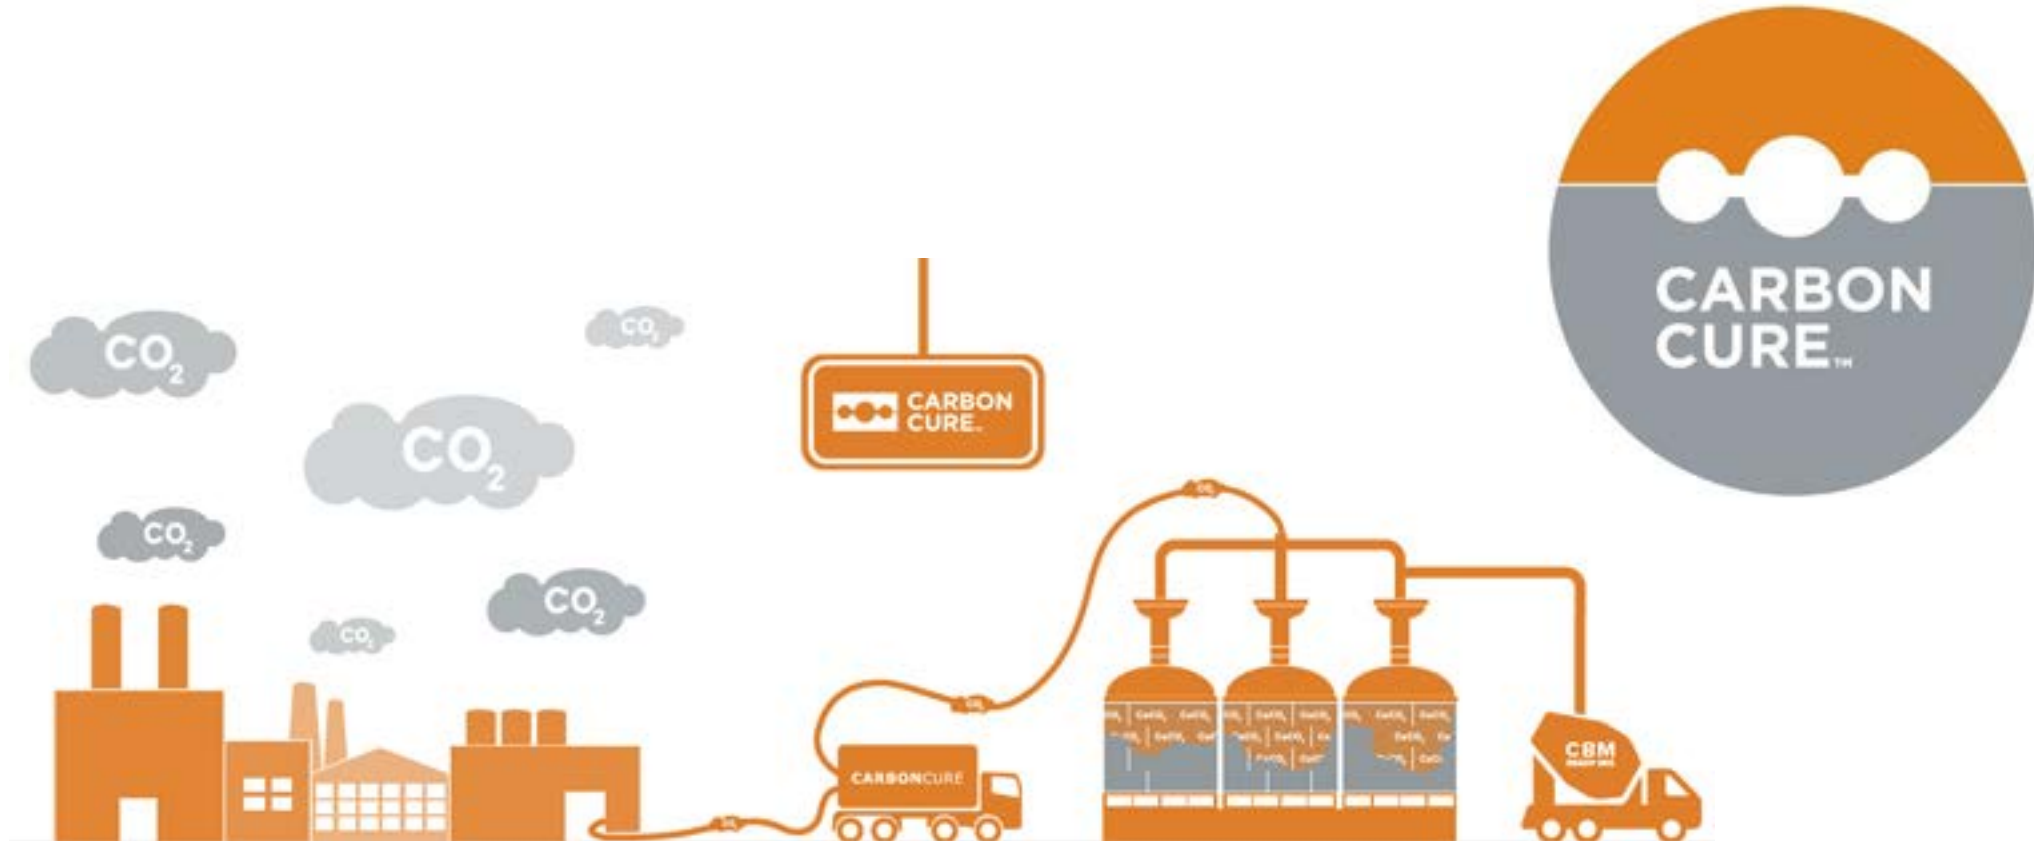



ID 6a6bb79174
April 27, 2021

Carbon Savings Estimate

For the MCMURRAY METIS CULTURAL CENTRE in FORT MCMURRAY, ALBERTA
Estimate assumes 10000 m³ of concrete

Concrete for this project made with
CarbonCure can potentially save:

...which is equivalent to:



207,599

Kgs of CO₂



109.7

Hectares of trees absorbing CO₂ for
a year



829,030.6

Kms of driving in a gas-powered car

About CarbonCure

The CarbonCure Technology is installed in concrete plants to inject waste CO₂ into fresh concrete. Once injected, the CO₂ becomes converted into a mineral and permanently embedded in the concrete.

The mineralized CO₂ improves the concrete's compressive strength, enabling concrete plants to adjust concrete mixes to achieve further carbon reductions without compromising the concrete's quality. The resulting concrete meets the same strength, durability and fresh properties as the original mix, but with a reduced carbon footprint.

Our Impact With CarbonCure





MCMURRAY
MÉTIS

Municipal Permits

- Grading Permit
 - Approved on March 31, 2021
- Development Permit for the Metis Cultural Centre
 - Approved on April 13th.
- Building Permit – Foundation
 - Submitted.



McMURRAY MÉTIS

CULTURAL CENTRE





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MÉTIS

Questions?

